

DETAILS

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201 St. Joseph Street

Summary of Request:

Remove existing windows on west elevation and replace with 'blind' windows

Applicant (as applicable):

Element 3 Engineering LLC

Property Owner:

St. Joseph Street Project LLC

Historic District:

DeTonti Square

Classification:

Not listed

Summary of Analysis:

- A survey was completed of the windows proposed for replacement. They were found to be significantly deteriorated
- The proposed replacement 'blind' windows fit the existing openings and match the existing in dimension, profile, and configuration
- All proposed materials are approved for window replacement in local historic districts
- The property is located in the DDD and has undergone CRC review

Report Contents:

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PROPERTY AND APPLICATION HISTORY

DeTonti Square Historic District was initially listed in the National Register in 1972 under Criterion A for social and urban planning significance and Criterion C for significant architecture. The district was one of two historic districts created by a municipal ordinance in 1962 in an effort to halt the rapid demolition of historic buildings near the city's central business district. The district, named for the French explorer Henri DeTonti, contains a few structures surviving from the 1830s, but the majority were built in the 1850s as residences of the wealthy and influential cotton factors, merchants, and planters.

The present parcel at 201 St. Joseph Street stretches from State Street to the north to St. Anthony to the south and consists of two one-story masonry structures which were originally automotive businesses. The parcel as it exists today was once made up of three lots facing St. Joseph Street and one lot fronting State Street. 1885 Sanborn Insurance Map shows the three St. Joseph Street lots occupied by four large one-and-a-half to two-and-a-half story frame and masonry dwellings. Most had full-width front porches and off-set rear projections. The State Street lot contained five two-story masonry terrace homes and one one-and-a-half story frame home. These dwellings appear on the two subsequent overlays from 1891 and 1904. The southernmost dwelling facing St. Joseph Street is not present on the 1924 map. By the time of the 1955 Sanborn survey, the dwellings are all gone and the present buildings are extant. Aerial photography reveals that these structures were built between 1940 and 1952.

According to Historic Development records, this property has appeared once before the Architectural Review Board (ARB). In 2013, an application was approved to demolish a two-bay vehicular wind on the northeast corner of the property's northernmost building.

SCOPE OF WORK

- 1. Remove existing metal windows on west elevation and replace with 'blind' windows.
 - a. The replacement blind windows would consist of wood muntins of similar profile to original, painted white. Existing metal grilles would remain. Glazing would be opaque.
 - b. The replacement blind windows would fit the existing opening and would match the existing in lite configuration. Existing brick sill would remain.

APPLICABLE STANDARDS (Design Review Guidelines for Mobile's Historic Districts)

- 1. **5.20** Preserve the functional historic and decorative features of a historic window.
 - Where historic (wooden or metal) windows are intact and in repairable condition, retain and repair them to match the existing as per location, light configuration, detail and material.
 - Preserve historic window features, including the frame, sash, muntins, mullions, glazing, sills, heads, jambs, moldings, operation, and groupings of windows.
 - Repair, rather than replace, frames and sashes, wherever possible.
 - For repair of window components, epoxies and related products may serve as effective solutions to material deterioration and operational malfunction.
- 2. **5.21** When historic windows are not in a repairable condition, match the replacement window design to the original.
 - In instances where there is a request to replace a building's windows, the new windows shall match the existing as per location, framing, and light configuration.
 - Use any salvageable window components on a primary elevation.
- 3. **5.22** When a historic window is missing on a key character-defining wall, use a historically accurate replacement.
 - Historically accurate light patterns shall be employed. Use photographic, physical, and/or documentary evidence for the design.

- A new window shall be installed in such a manner as to fit within the original window opening and match in depth and filling of the reveal. A reveal is the part of the side of a window opening that is between the outer surface of the wall and the window.
- A double-paned or clad wood window may be considered as a replacement alternative only if the replacement matches the configuration, dimensions, and profiles of original windows.
- For increased efficiency, storm windows can be installed. A storm window shall fit within the window reveal and avoid damaging window casings. Operable storm windows are encouraged.

ACCEPTABLE WINDOW MATERIALS Materials that are the same as the original, or that appear similar in texture, profile and finish to the original are acceptable.

These often include:

- » Wood sash
- » Steel, if original to structure
- » Custom extruded aluminum
- » Aluminum clad wood
- » Windows approved by the National Park Service

UNACCEPTABLE WINDOW MATERIALS Materials that do not appear similar to the original in texture, profile and f finish are unacceptable.


These often include:

- » Vinyl
- » Mill-finished aluminum
- » Interior snap-in muntins (except when used in concert with exterior muntins and intervening dividers)

STAFF ANALYSIS

A portion of the parcel under review is located in the DeTonti Square Historic District. The submitted application proposes replacing the existing windows with blind windows that are similar in profile to the original.

The *Guidelines* prioritize preservation of an original window over replacement. However, when original or historic windows are not repairable, selected replacement design should match that of the original. (5.21) The submitted window survey reveals failing window components along the west elevation due to significant deterioration. The proposed replacements are similar to the original in dimension, profile, and configuration. The proposed project has made every attempt to retain all original material that is still structurally sound, such as the brick sills and metal grilles. The proposed wood muntins resemble the original in profile and will be painted white to further match what is there now. All materials are approved for replacement windows in historic districts. The windows proposed for replacement are located on the west elevation; a rear elevation which is minimally visible to the ROW. The windows on the north end of the west elevation have been replaced previously.

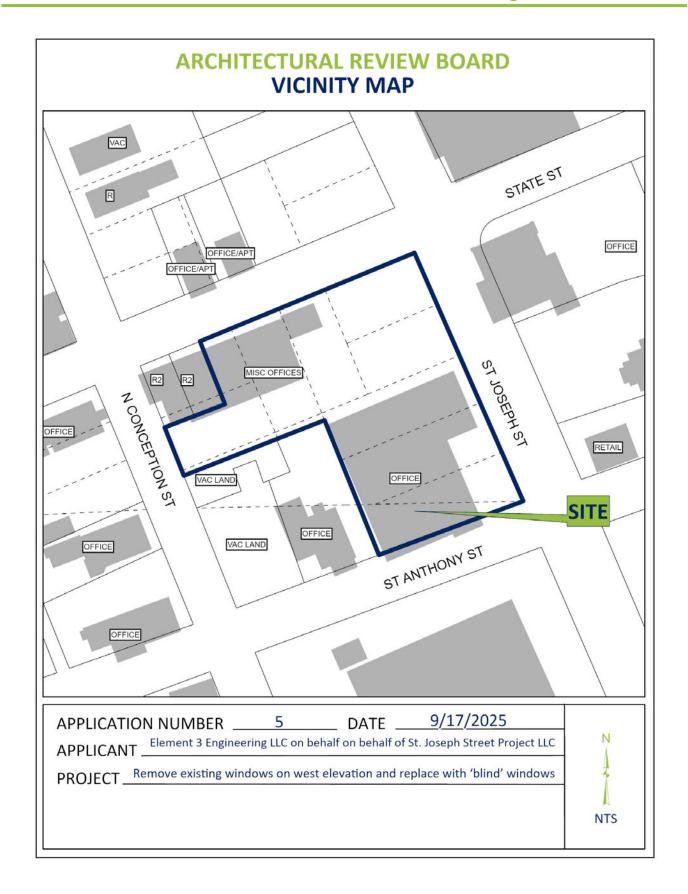

Site Photos – Northwest corner of N. Claiborne and Congress Streets



1. View of building looking NW



2. View of south elevation, looking NE



3. View of north side of west elevation, looking NE



4. View of west elevation (windows to be replace looking SE)



5. Detail of existing window condition



6. Detail of existing window condition



City of Mobile · Historic Development

Architectural Review Board Application

Date of Application	Date Received
201 St. Joseph Street Address of Property	
Does any party hold a façade easement on this property? Note that the specific work outlined application by the ARB. \$50,000.00 Cost of Project (Required)	
St. Joseph Street Project LLC	
Owner Name Phone	Email
7420-D Hitt Road Mobile, AL	36695
Address	Zip Code
Allen Williams	
Owner's Representative Name Phone	Email
3938 Government Blvd. A-104 Mobile, A	AL 36693
Address	Zip Code
Describe the Proposed Work: Remove existing windows and replace wattached plans for window locations to be	
Please see attached renderings for prop	

Does the work involve demolition of a structure?

No O Yes Please fill out demolition portion of application.

Does the proposed work involve signage? **● No ○** Yes

Will the proposed work require the removal of any trees from the site?

No O Yes

If yes, attach a detailed site plan showing all trees and landscaping that will be removed and contact the Urban Forester at 208-7091 for Tree Permitting Requirements.

REQUIRED PLANS: If plans are required for the project, please attach the following:

- Attach two (2) sets of plans: one large scale set and one 11"x17" reproducible set,
- Also attach one set of photographs to the application.
- If available, electronic plans should also be submitted as a TIFF or PDF.
- A \$15 or \$5.00 application fee is due upon filing. Check should be made out to the City of Mobile.

Refer to the following checklist for requirements for specific work items to be performed. Refer to the Design Review Guidelines for Mobile's Historic Districts (https://www.buildmobile.org/architectural-review-board/). Staff is available to assist with application preparation. For large projects, such as new construction or substantial additions or renovations, consultation with staff is strongly encouraged. Applications are reviewed in the order in which they are received, and if review by the Architectural Review Board is required, an application will be placed on the next available agenda. Any incomplete applications may be held until all information is submitted.

Staff Reports: The Historic Development Staff will review your application and generate a report that will be sent to you, along with the meeting agenda, via e-mail approximately one week before the meeting. The meeting agenda may be found at https://www.buildmobile.org/architectural-review-board/. Please examine these and be prepared to discuss any issues at the Board meetings. Questions before the meeting should be addressed to the staff of the Historic Development Department.

Alterations to Approved Plans: A new application must be submitted for changes to the approved plan. Minor alterations may be approvable by staff.

Historic Markers: The Architectural Review Board examines applications based on its adopted guidelines for historic preservation. These are based on a minimal standard set by the City of Mobile and the State. Historic markers are awarded by the Mobile Historic Development Commission based on a higher standard of review. Approval by the ARB does not guarantee approval for a historic marker. If the desire is to qualify for a marker, please inform the Board and it will attempt to guide you toward the higher goal.

Conflicts of Interest: ARB members sit as a quasi-judicial body. All its deliberations must be made in an open meeting. It is illegal for a Board member to discuss an application outside of a meeting with anyone but staff. Conflicts of interest, if any, will be disclosed at the meeting.

Public Notice: A sign will be placed in a conspicuous location on the property prior to the Review Board meeting to notify surrounding property owners of a pending application. Attendance at the meeting is strongly advised in order for the applicant to respond to any questions.

NOTE: INCOMPLETE APPLICATIONS WILL NOT BE PLACED ON THE AGENDA

Use the Following Checklist to Ensure a Complete Application Complete each box that applies:

	NEW CONSTRUCTION, ADDITIONS, OR EXTENSIVE RENOVATION/REPAIR TO EXISTING STRUCTURES
1.	One large set and one 11 x 17 (reproducible) set of scaled drawings which shall include:
a.	A complete site plan illustrating the proposed construction, its location, with dimensions, required
	setbacks, landscaping and other site amenities;
b.	Floor plans, with dimensions, as they impact the exterior of the building, including existing plan and proposed plan;
c.	Square footage of the original building with square footage of all additions including the proposed addition;
d.	A drawing, with dimensions, of all affected exterior elevations;
e.	Notes describing all exterior materials (i.e. walls, roof, trim, cornice, windows, etc.) Sample materials may be required in some cases (consult with staff);
f.	Detailed drawings or photographs of all decorative architectural details (i.e. columns, balustrades, modillions, etc.);
g.	Paint samples and plan keyed to location of each color. (See below)
2.	Photographs of the subject property to be worked on and surrounding buildings are required.
	Subject Property photographs
	Surrounding Buildings photographs
acc	Historic Development Office can provide sample plans for garages, carports, and outbuildings. These are generally eptable for most domestic sites. Note: These are for design purposes only and are not suitable as construction wings.
ura	wings.
ura	FOR MINOR RENOVATION OR REPAIR TO EXISTING BUILDINGS
1.	FOR MINOR RENOVATION OR REPAIR TO EXISTING BUILDINGS For work which includes changes to the exterior of existing buildings, the following is required: X Elevation drawings with dimensions and material details
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1. 2.	For MINOR RENOVATION OR REPAIR TO EXISTING BUILDINGS For work which includes changes to the exterior of existing buildings, the following is required: X
1. 2. 3.	For work which includes changes to the exterior of existing buildings, the following is required: X
1. 2. 3.	For work which includes changes to the exterior of existing buildings, the following is required: X Elevation drawings with dimensions and material details X Floor plans X Photographs of each face of the building to be renovated with details of the areas of work. EXTERIOR PAINTING
1. 2. 3.	For work which includes changes to the exterior of existing buildings, the following is required: X
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 FENCES, DRIVES AND GATES A drawing or photograph of the type of fence, wall or gate with the height noted. A site plan, with dimensions, showing the placement of any proposed change to the property as it relates to property boundaries and all other building or site facilities.
3 A description of the materials to be used. 4 Paint samples, if the fence, wall or gate is to be painted.
SIGNAGE
Width of signfeetinches Height of sign:feetinches
Single Face Double Face
Height (from ground level to top of sign)feetinches
Height (from ground level to bottom of sign)feetinches
Total Square Footage of Signage: square feet. (Both sides if double-faced)
General Description
Type of Sign: ☐ Monument ☐ Free Standing ☐ Projecting ☐ Wall ☐ Banner ☐ Sandwich Board
How will sign be mounted:
Sign Materials (sample materials may be requested by the Review
Board):
Describe type of lighting to be used:
Linear front footage of principle building: feet inches.
Square footage of Existing Signage:feetinches N/A
Include in Application:
Scaled colored renderings of the requested sign; or photographs with dimensions
Photographs of the building
A site plan or building elevation showing the location of the proposed signage For specific requirements, refer
to Sign Design Guidelines for Mobile's Historic District and Government Street.

DEMOLITIO	ON APPLICATION
Purchase Date:	Purchase Price:
Current appraised value of the property?	(N/A if Not Available)
Was the property occupied at time of purchase? condition?	What was the property's
conditions	
What alternatives to demolition have you considered for	this property?
Have you listed the property for sale or lease since your p	ourchase? O Yes O No
If "Yes", what was your asking price?	
How many offers did you receive?	
List any options currently held for the purchase of the pro-	perty, including the price received for such option, the
conditions placed on such option and the date of expiration	on of such option:
Do you have construction plans ready to complete the rep	placement project? O Yes O No
If so, how much have you expended on the plans?	
What are the dates of these expenditures?	
In order to determine your ability to complete the replace	cement project, do you have the following:
Performance Bond O Yes O No	Letter of Credit O Yes O No
Trust for completion of improvements O Yes O No	Other evidence of financial ability O Yes O No
Letter of commitment from a financial institution O Yes	O No
"In no event shall the Board entertain any application for unless the applicant also presents at the same time the produces #44-084	• • • • • • • • • • • • • • • • • • • •

An Architectural Review Board Application with supporting documentation and fee should accompany this request with the plans for development of the site. A sign will be placed in the front yard of the property prior to the Review Board meeting to notify surrounding property owners of a pending application. Attendance at the meeting is strongly advised in order for the applicant to respond to any questions.


SEE NEXT PAGE

CONFLICTS WITH OTHER CITY DEPARTMENTS


The Architectural Review Board examines applications solely on the basis of impairment to the historic character of a building or neighborhood. Approval by other City Departments may consider other aspects of a project such as safety. When multiple regulations are in conflict, generally the most restrictive applies. Also, though the staff and Review Board try to inform applicants of possible conflicts, they may not be aware of all the implications of a request. Therefore, the property owner should clear all requests with the appropriate departments.

Relit & lang	8/5/25	
Signature	Date	



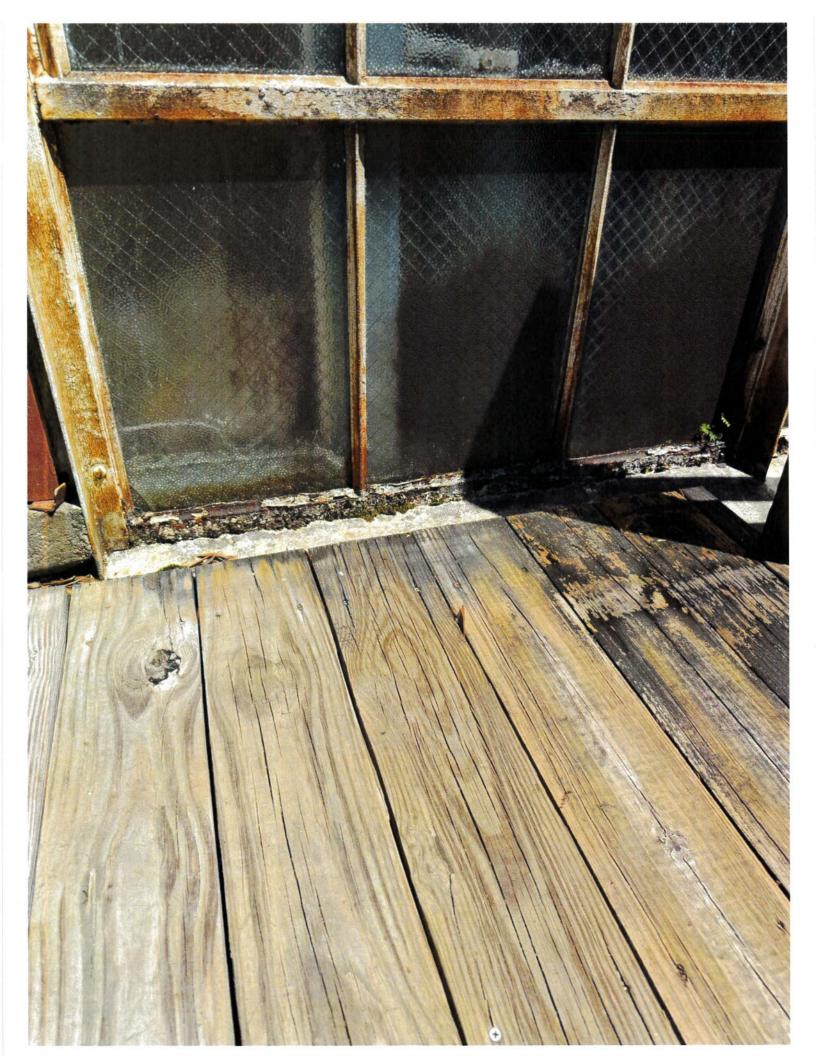



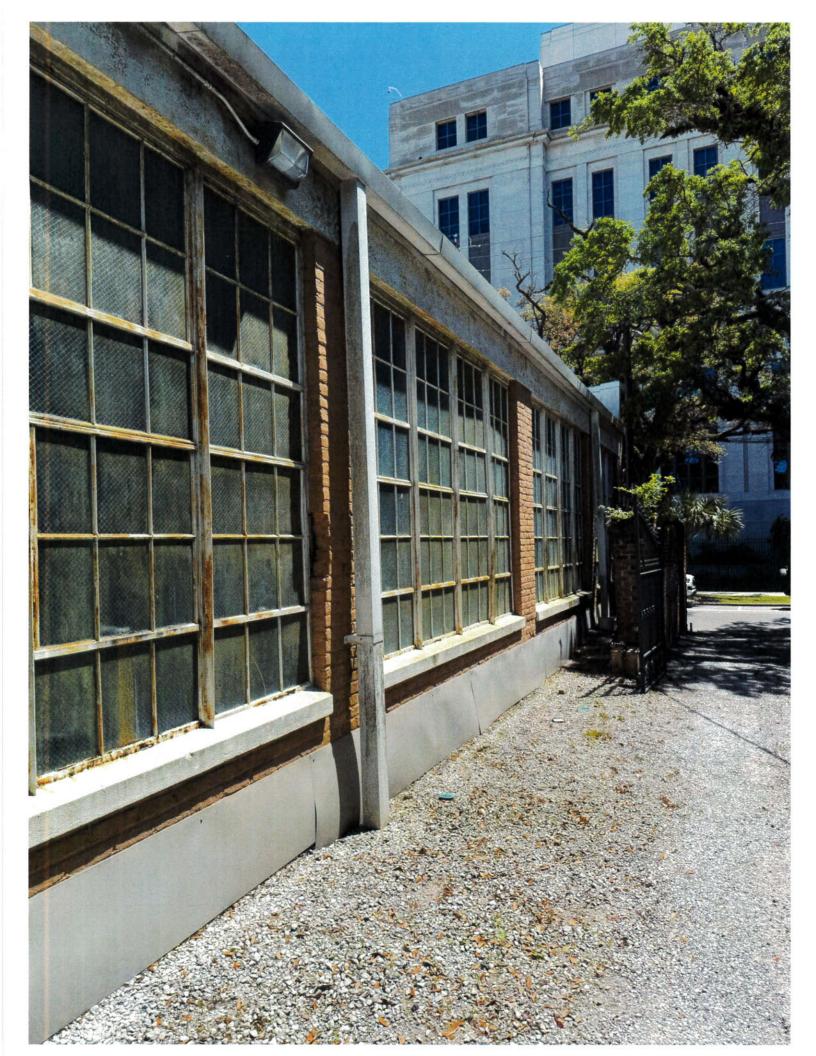



Proposed South Elevation



Proposed South West Elevation




Proposed West Elevation


201 ST. JOSEPH ST.

WINDOW REMODEL 201 ST. JOSEPH STREET, MOBILE, AL 36602

INDEX OF DRAWINGS G1.0 COVER SHEET G2.0 CODE SUMMARY

DEMOLITION PLAN FLOOR PLAN STRUCTURAL DETAILS

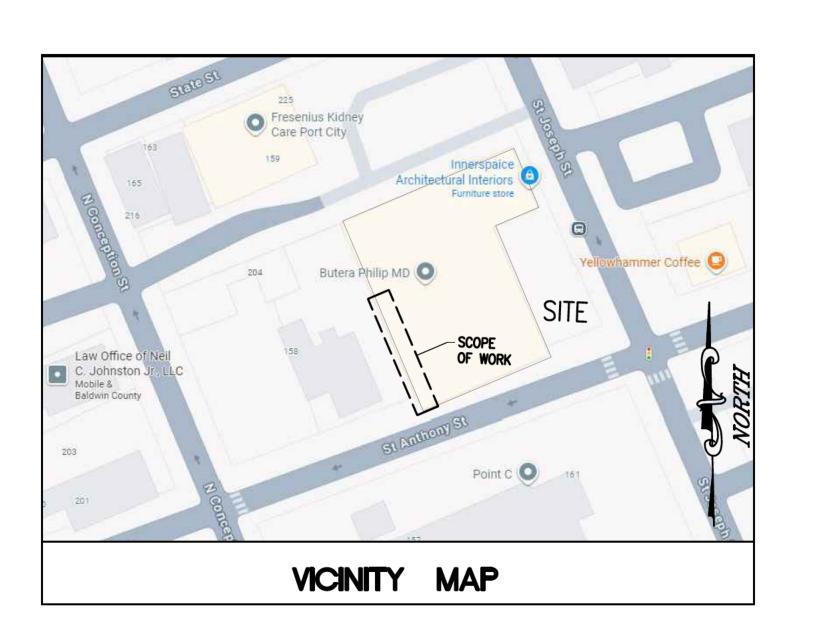

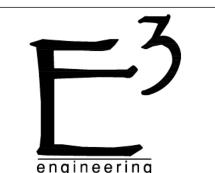

Element engineering
3938 GOVERNMENT BLVD

SUITE 104 MOBILE, AL. 36693

	Approved	FAD			
REVISIONS	Description	AS PER CRC COMMENTS			
	Date	8.28.25			

01 ST. JOSEPH STREET

²H STREET, 36602

PRE-PERMIT SUBJECT TO CHANGE

JOB NO. 25-043
DATE: 08/13/2025
DRAWN BY: JBG
SCALE: SHOWN

SHEET NO.

G1.0



City of Mobile · Permitting

Clear form

Building Code Summary

	For All Commercial Project
Information to be copied and placed on draw	ings

004 07 1007011 07			
201 ST. JOSEPH ST.			
Name of Project			
201 ST. JOSEPH STREET, MC	DBILE, AL 36602		
Address			
WINDOW REMODEL			
Proposed Use			

Codes used in design (Check all that apply)

Architects Letter of Supervision Provided?

2021 International Building Code 2020 National Electrical Code 2021 International Existing Building Code 2021 International Mechanical Code

2021 International Fire Code 2021 International Plumbing Code

2015 International Energy Conservation Code
2021 International Fuel Gas Code **Construction Description**

Scope of Work - Building: EXISTING WINDOWS SPECIFIED ON PLANS TO BE REMOVED & FILLED WITH NEW BLIND WINDOWS.

Scope of Work – Mechanical / Refrigeration:

Build Mobile, PO Box 1827, Mobile, Alabama 36633

For more information: www.BuildMobile.org | permitting@cityofmobile.org | 251.208.7198

Visit our help window: Mobile Government Plaza, 205 Government Street, Third Floor South Tower Revised November 2024

Fire Rated Elements	Required Rating	Hourly Rating	UL No.
Ceiling-Floors			
Beams			
Columns			
Ceiling-Roofs			
Shafts-Exit			
Shafts-Other			
Corridor separation			
Occupancy separation			
Party/Fire wall separation			
Smoke barrier separation			
Tenant separations			

- All fire rated walls shall be identified on plans by hatching, shading, etc.; show legend.
- Identify code section when using any special exceptions, etc.
- Reproduce full UL. Or other approved agencies details or reproductions of rated assemblies/penetrations on the

Draft Stopping (IBC 718.3 & 718.4) Draft stopping in floor? O Yes O No Draft stopping in attic? O Yes O No

Accessibility (IBC 11) Does the design conforms to IBC Chapter 11 and ICC A117.1-2017? If no, explain below condition that will not allow building to be accessible:

Design Loads (City Ordinance 1609.3)

Ultimate Design Wind Speed (IBC 1609 or ASCE 7) ☐ Risk Cat. I-145MPH Risk Cat. III-169MPH ☐ Risk Cat. IV-179MPH

Live Loads (IBC 1607) Roof N/A PSF Attic N/A PSF

Wind-Borne Debris Region (IBC 1609) This building will use impact resistant glass per (IBC 1609.2)?

Yes O No

This building will use engineered shutters or other approved method? O Yes O No

Flood Requirements (IBC 1612) All projects located in a Special Flood Hazard Area shall comply with the City of Mobile Storm Water Management and Flood Control Ordinance. Does this project comply? O Yes **②** No If no, explain why:

I have reviewed the requirements of IBC Section 17, specifically 1705; the design incorporates the requirements and is reflected on the drawings and in the specifications. Below are the requirements to be included:

Safety Glazing for Hazardous (IBC 2406) I have identified on drawings where tempered glass is required in hazardous locations (2406.4) Yes O No

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> > IPC TABLE 403.1 – TOTAL NUMBER OF REQUIRED FIXTURES

Revised November 2024

Mezzanine N/A PSF

i Otai L	.ot Area (sf)	N/A			GIUSS A	iea Oi Bi	unuing A	ii iioors (sf) <u>N/A</u>	
	Building Footprint*					_		N/A		
	nclude all buildings		-	ıng aetad	•		•			
Numb	er of Stories:	1			Is there	a basen	nent?	O Yes	Ø No	
The bu If yes,	g Buildings uilding will remain i add provisions for u able provisions of I	rigid safet	y barrie	rs and du	st barrier	-	ect the p	ublic duri	ing construction in ac	cordance with th
Provid	e Level of Alteration	ons per IE	ВС	X 1	□ 2	□ 3				
Is the	ations (Change of work in this buildin			ng the oc	cupancy	type or u	se?	○ Yes	⊗ No	
	ic Buildings building a Historic	Building?	⊗ Yes	O No						
Constr	uction Type	□ IA □ IVA	□ IB □ IVB	□ IIA □ IVC	XI IIB □ IVHT	□ IIIA □ VA	□ IIIB □ VB			
Occup	ancy Classification									0
	Assembly 303		□ A	-1 🗆	A-2	□ A-3		A-4	□ A-5	Occupant Load
X	Business 304									
	Education 305									
	Factory Industria	l 306	□ F-	.1 □] F-2					
	High-Hazard 307		□н	-1 🗆	H-2	☐ H-3		H-4	☐ H-5	
	Institutional 308		□ I-	1 🗆	l-2	□ I-3		I-4	Condition	
	Mercantile 309									
	Residential 310		□ R-	-1 🗆	R-2	☐ R-3		R-4		
	Storage 311		□ S-	1 □] S-2			High-pile	d	
	Utility & Miscella	neous 312	2							
								TOTA	AL OCCUPANT LOAD	0
Buil	ding Element				Require	ed Rating	UL No). *		
Stru	ctural frame; colur	nns, girde	ers, truss	es						
Bea	ring walls exterior									
Bea	ring walls interior									
Nor	n-bearing walls & pa	artitions e	exterior							
Non	n-bearing walls & pa	artitions i	nterior							
Floo	or construction; sup	porting b	eams ar	nd joists						
Roo	f construction; sup	porting b	eams an	d joists						
	nkler system?				☐ Yes		□ No		□ Partial	

☐ Yes

O Yes

Build Mobile, PO Box 1827, Mobile, Alabama 36633

For more information: www.BuildMobile.org | permitting@cityofmobile.org | 251.208.7198

Visit our help window: Mobile Government Plaza, 205 Government Street, Third Floor South Tower

☐ No ☐ Wet ☐ Dry Class____

O No

Standpipes?

Fire / Smoke Alarm?

		OCCUPANCY	OCCUPANT		VA/ATED	CLOSETS			AVATOR	RIFS
		00001711101	OCCUPANT	WATER CLOS		CLUSE 13	ETS LAVA		AVATOR	(ILJ
			LOAD	Ratio	Men	Ratio	Women	Ratio	Men	Wome
	Required	N/A								
	Total									
			1		'	'	1			
		DRINKING	SERVICE	MISC	MISC					
		FOUNTAIN	SINK							
	Required	N/A	5.1111			1				
	Total	.,,,,				+				
	Total									
	Fire Department Req building. Required water supp Method Used:	ly <u>n/a</u> gpm	@ <u>N/A</u>	_ PSI						ents to
		rance Service Office estitute of Technolog	-				University nal Fire Cod			
	Key Boxes IFC 506:									
ant Loads	Locks: O Yes O N	lo								
ant Loads	**required for building	ngs with fire protecti	on systems, gat	tes, non-st	tandard fi	re service	access i.e.,	elevator	S	
	Provide a Life Safety **At a minimum, the access, exit capacity,	Plan (LSP) for all cor Life Safety Plan shal maximum travel dist	nmercial proje I illustrate the u ance, exit light	cts: 😧 \	∕es ○ No areas, occ	upant loa	-			
0	compliance Stateme **Where fire apparate installed and made se	nt required for Fire i	Approval: O water supply fo	or fire pro	tection are	-	to be instal	lled, such	n protec	tion sho
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	Compliance Stateme **Where fire apparate	nt required for Fire i	Approval: O water supply fo	or fire pro	tection are	-	to be instal	led, such	n protect	tion sha
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MOBILE FIRE - RESCUE DEPARTMENT FIRE CODE ADMINISTRATION

Address Visibility Chart Letter Height & Viewing Distance Chart Shows letter height (inches), Distance for Best Visibility

Letter Height (Inches) Ideal Readable Distance

3"	30'
4"	40'
5"	50'
<u>6"</u>	60'
7"	70'
8"	80"
9"	90'
10"	100'
12"	120'
15"	150'
18"	180'
20"	200'
24"	240'
26"	260'
30"	300'
36"	360'

Mobile Fire-Rescue Department / Community Risk Reduction/ Fire Code Administration 2851 Old Shell Road Mobile, AL 36607 (251) 208-7484

ENERGY EFFICIENCY REQUIREMENTS

2015 INTERNATIONAL ENERGY CODE CLIMATE ZONE = 2

ROOFS

METAL BUILDING ROOF R-VALUE METHOD = R-19 + R-11 LSU-VAULE METHOD = U-0.035

WALLS ABOVE GRADE

METAL BUILDING R-VALUE METHOD = R-13 + R6.5 CI U-VALUE METHOD = U-0.079

DPAQUE DOORS

SWINGING DOOR - U-VALUE = U-0.61

VERTICAL FENESTRATION

FIXED FENESTRATION

U-VALUE = 0.50ENTRANCE DOOR

U-VALUE = 0.83

LS = LINER SYSTEMCI = CONTINUOUS INSULATION



3938 GOVERNMENT BLVD

SUITE 104 MOBILE, AL. 36693

	Approved	FAD			
REVISIONS	Description	AS PER CRC COMMENTS			
	Date	8.28.25			

REMODEI

STREET 602

EPH 9 L. 366


201 ST. MOBIL

PRE-PERMI CHANGE

25-043 JOB NO. 08/13/2025 DATE: DRAWN BY: SCALE: SHOWN

SHEET NO.

CODE DATA

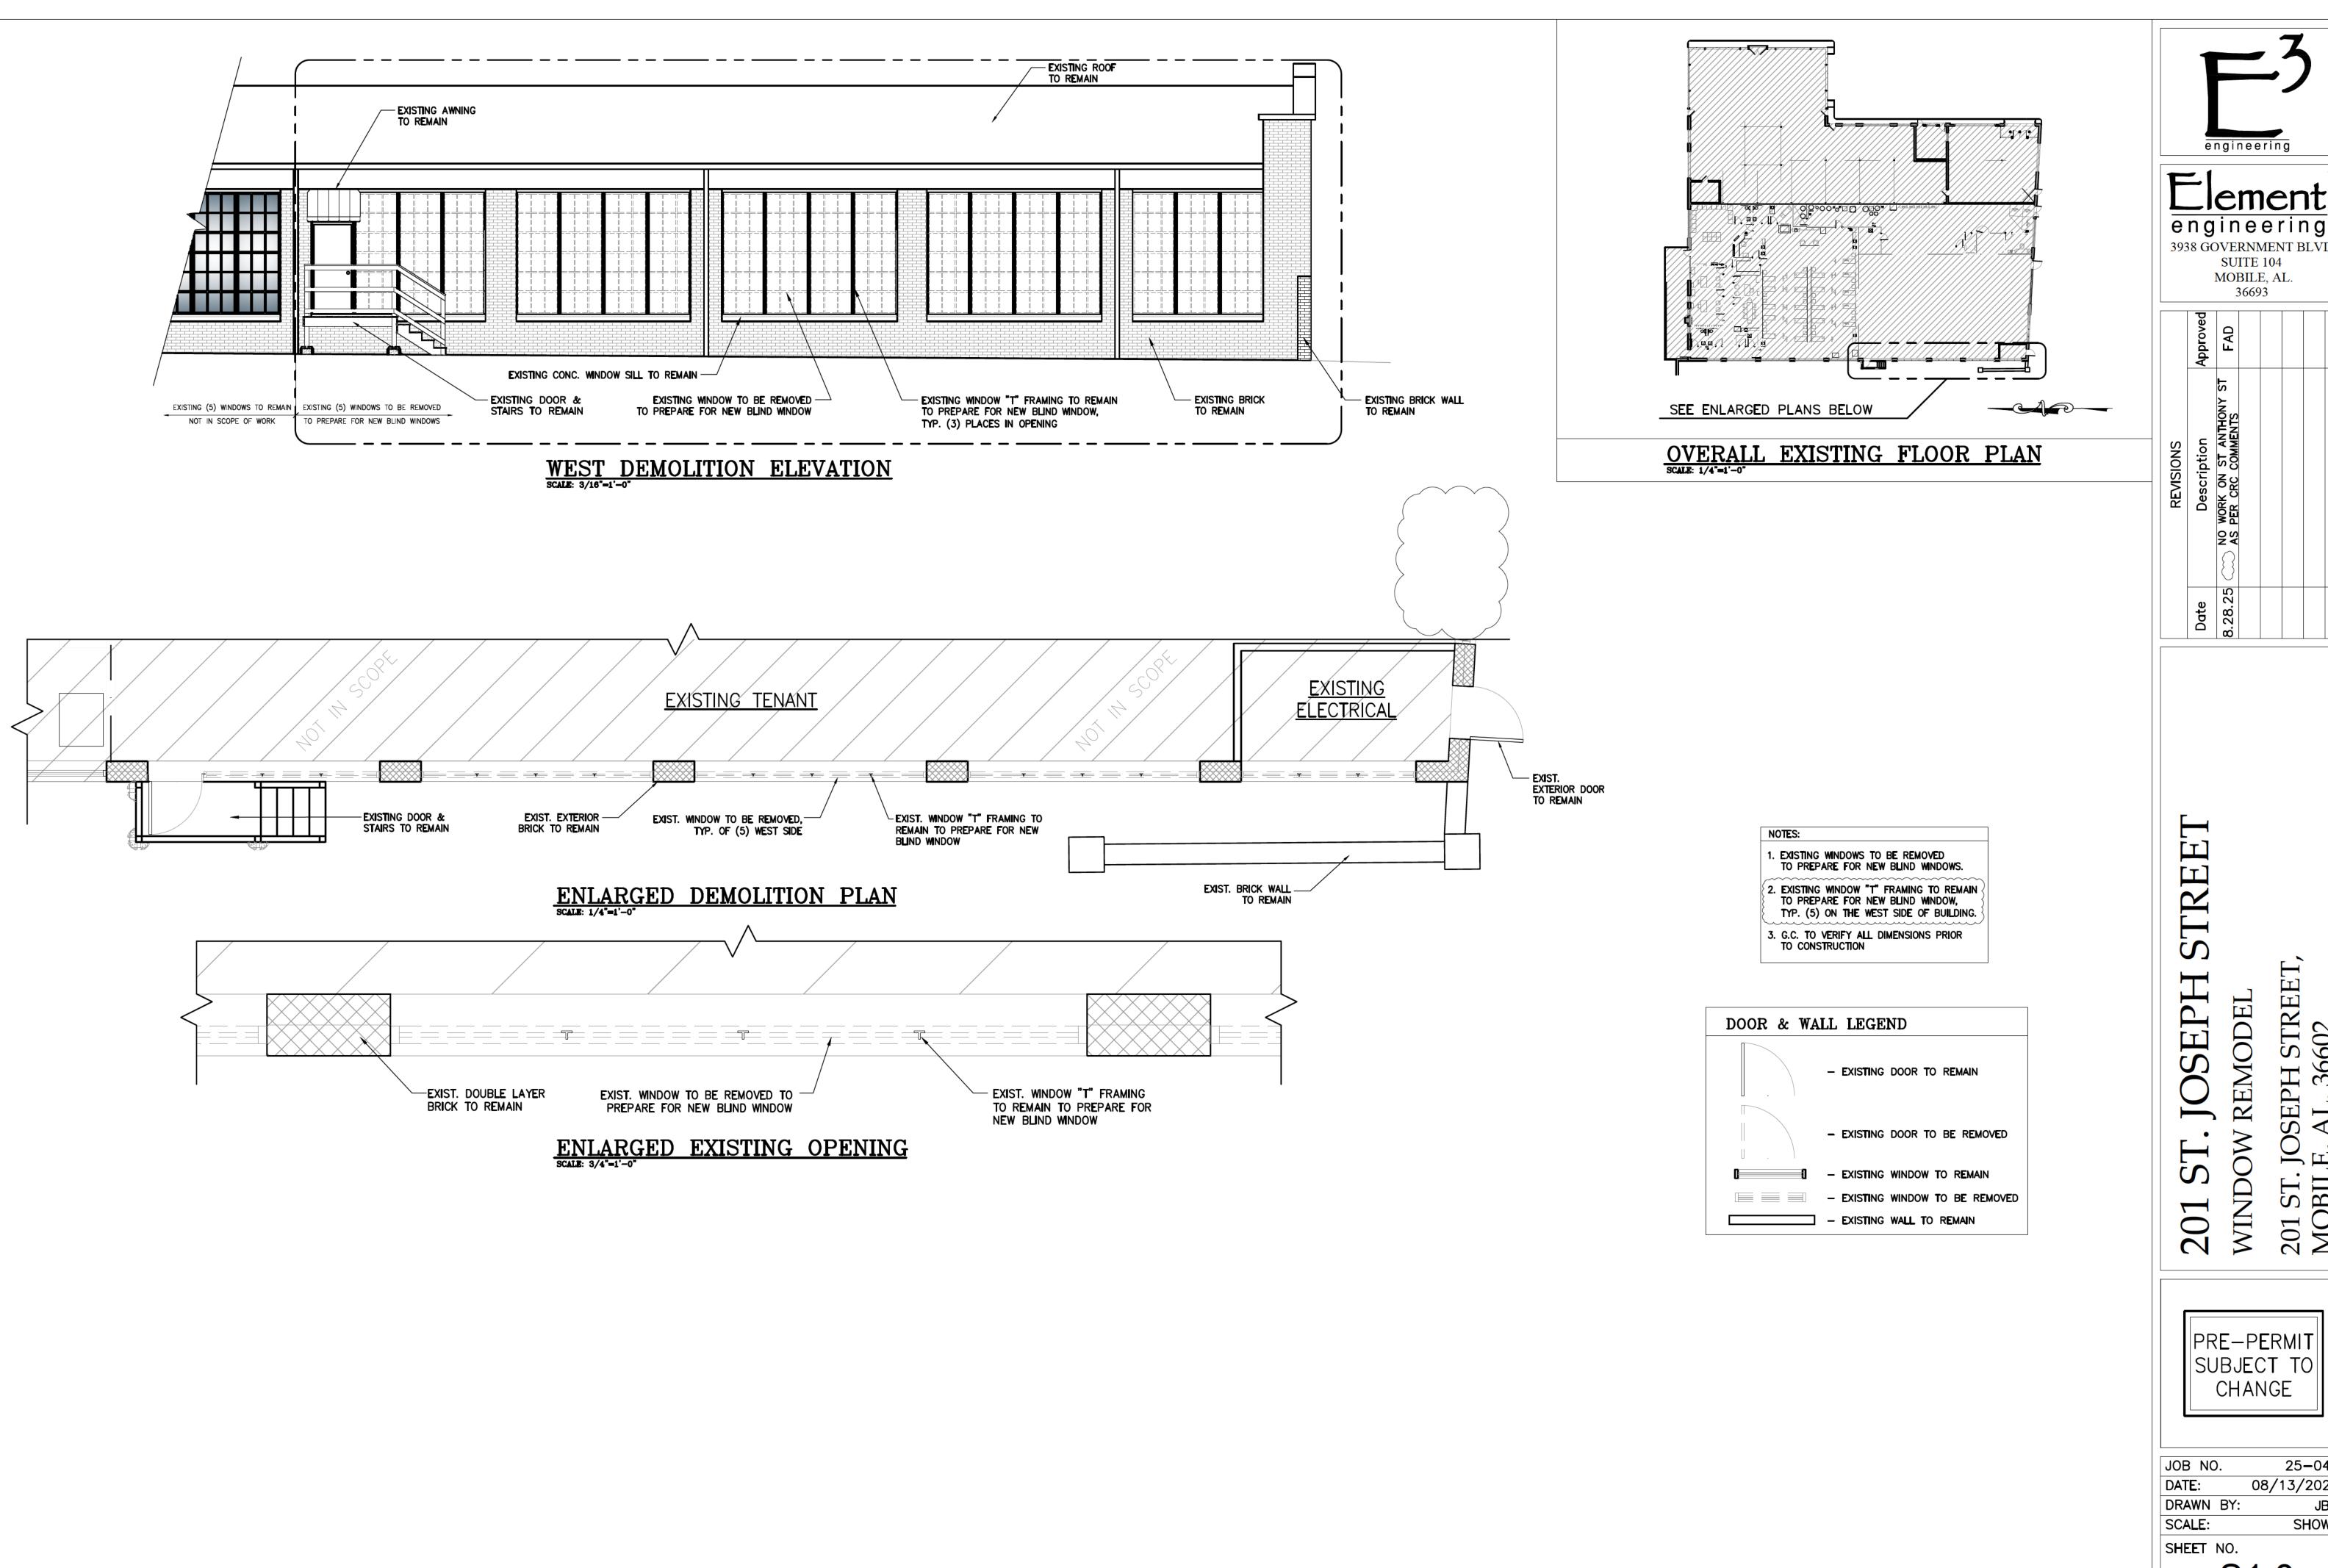

engineering

3938 GOVERNMENT BLVD SUITE 104 MOBILE, AL.

36693

REMODEL

. JOSEPH STREET, LE, AL. 36602

201 ST.] MOBILI


PRE-PERMIT SUBJECT TO CHANGE

JOB NO. 25-043 08/13/2025 DRAWN BY: JBG SHOWN

SHEET NO.

S1.0

DEMOLITION PLAN

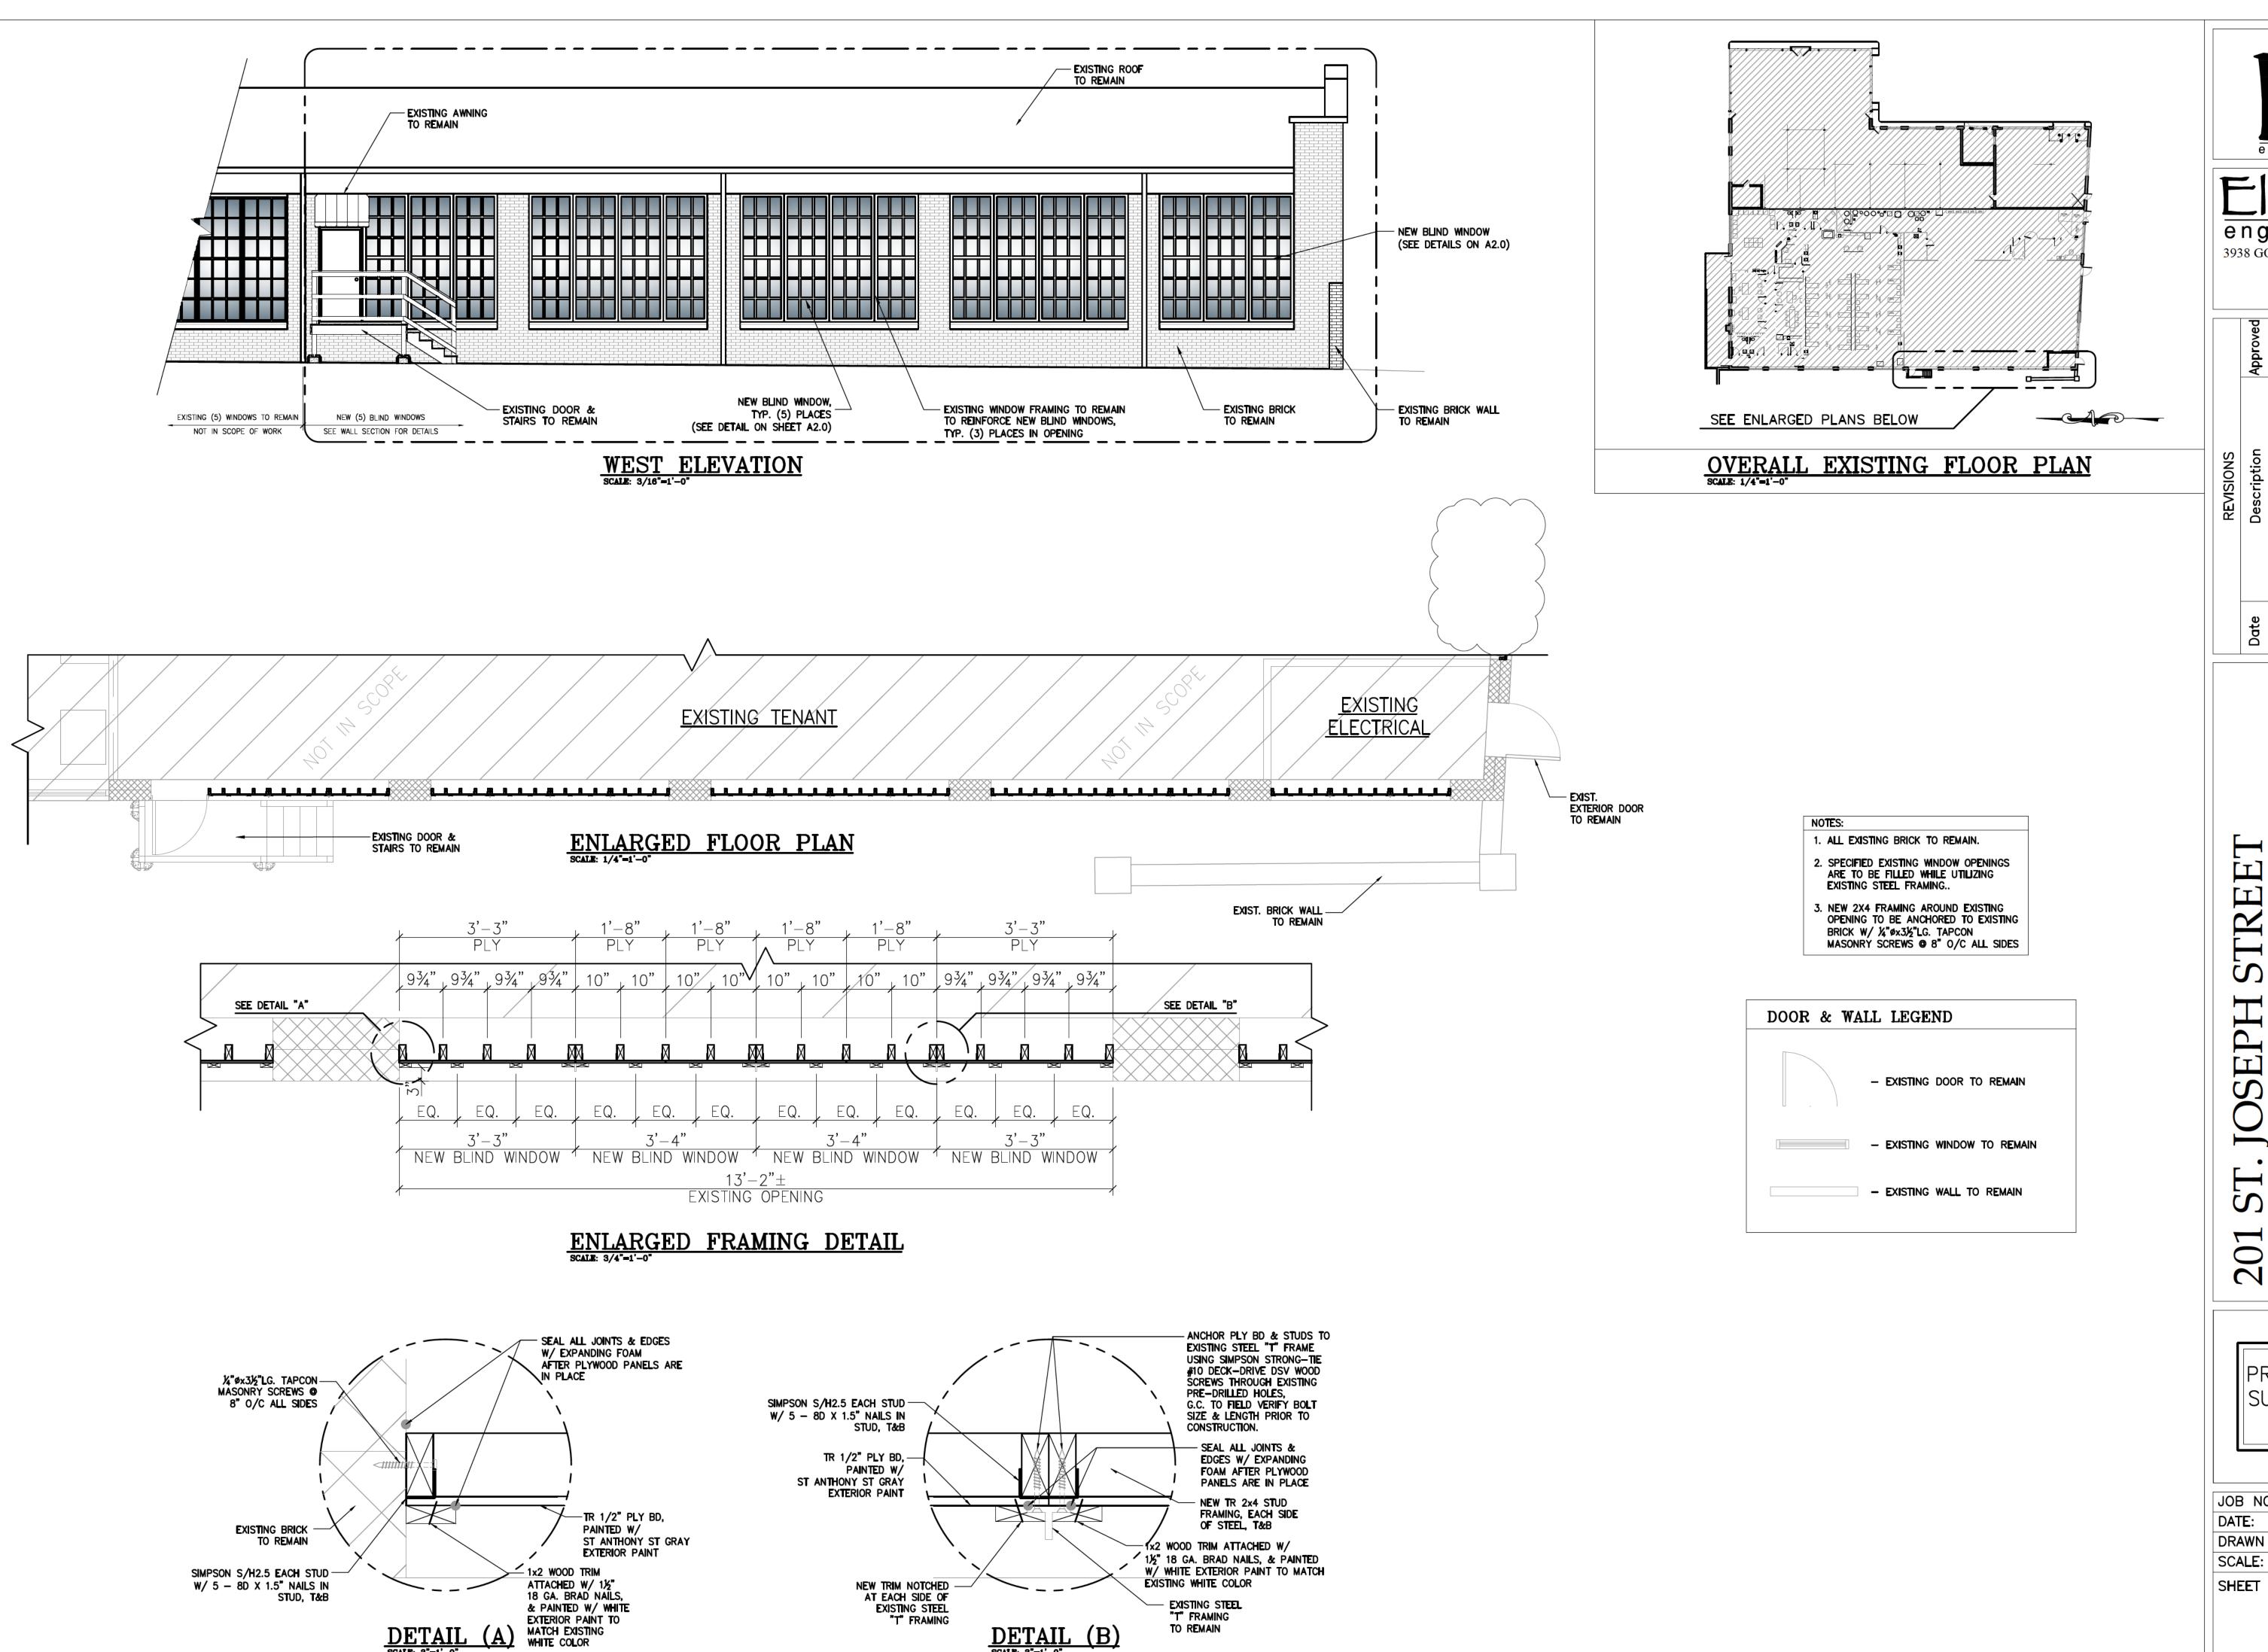

engineering

engineering 3938 GOVERNMENT BLVD

SUITE 104

MOBILE, AL. 36693						
Approved	FAD					
	Ë					

Approve	FAD			
Description	8.28.25 Cm NO WORK ON ST ANTHONY ST AS PER CRC COMMENTS			
Date	8.28.25			

PRE-PERMIT SUBJECT TO CHANGE

REMODEI

²H STREET, 36602

JOSEPH 36. E, AL. 36.


201 ST. MOBIL


JOB NO.	25-043
DATE:	08/13/2025
DRAWN BY:	JBG
SCALE:	SHOWN

SHEET NO.


S2.0

FLOOR PLAN

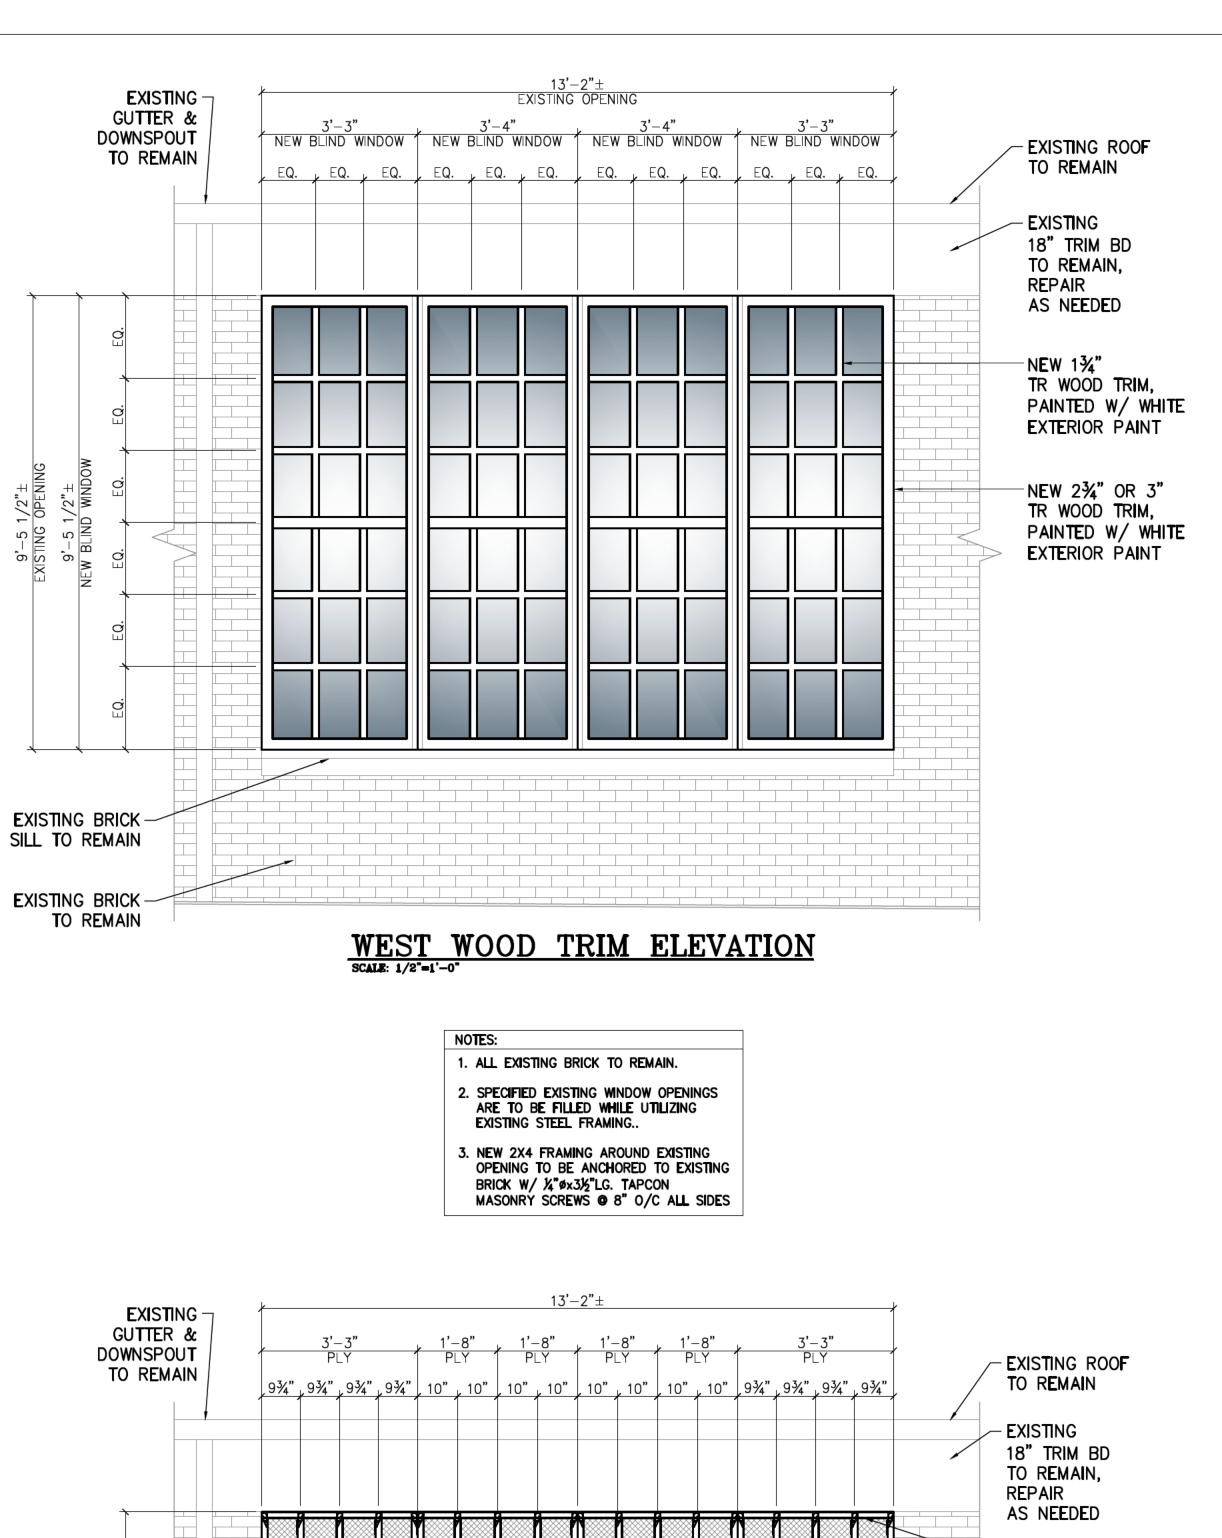

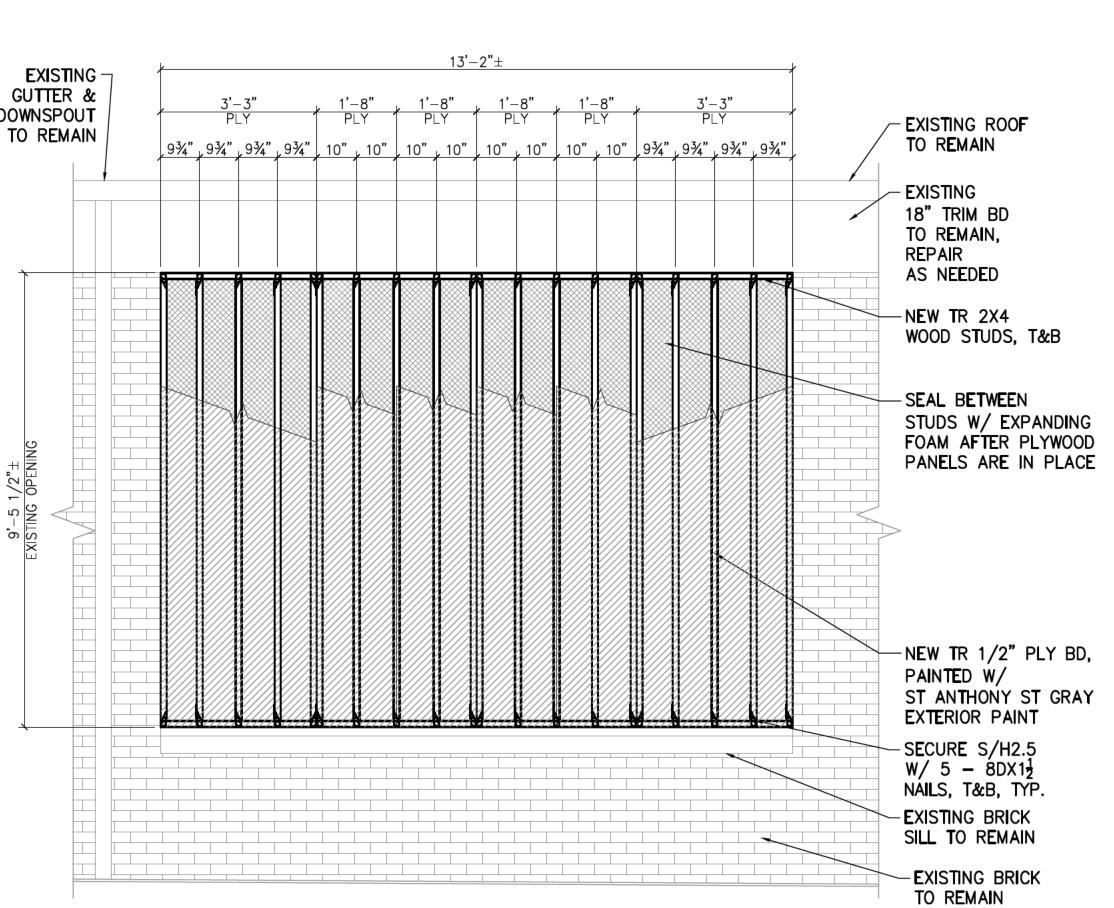


WEST WOOD FRAMING ELEVATION
SCALE: 1/2"=1'-0"

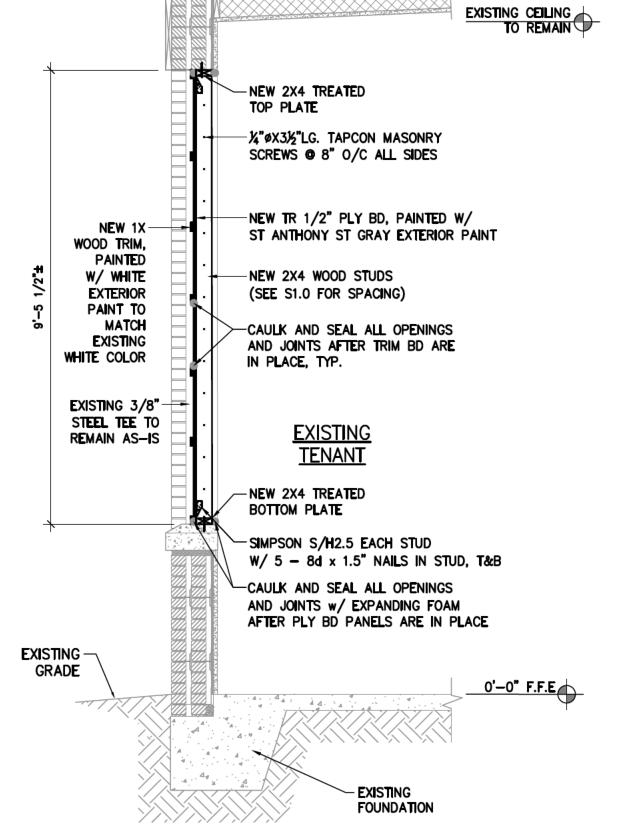

EXISTING ROOF TO REMAIN



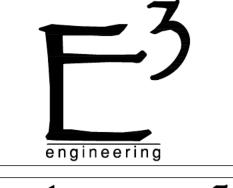

Element³
engineering
3938 GOVERNMENT BLVD
SUITE 104
MOBILE, AL.
36693

	Approved	FAD			
REVISIONS	Description	ON WORK ON ST ANTHONY ST			
	Date	8.28.25			

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. JOSEPH STREET, LE, AL. 36602

201 ST. MOBIL

REMODEL

25-043
08/13/2025
JBG
SHOWN

SHEET NO.

201

S3.0 STRUCTURAL DETAILS

${\sf City\ of\ Mobile\cdot Historic\ Development}$

Window Survey

Date of Application 201 St. Joseph Street Address of Property Overall Condition: Good Fair Poor (select one) Description of Conditions: Windows are cracked, broken. The metal rims are rusted and/or broken and can no longer hold windows in place. None of the window components are in functioning condition. Window Component Description of Issue/Problem FRAME: Sill please see above description Jambs Exterior trim & stops Interior trim & stops Interior wall surface SASH: Lowest rail please see above description Other rails & stiles Muntins & mullions Meeting rails (double- and single-hung)	Good Fair Poor	
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FRAME: Sill please see above description Jambs Exterior trim & stops Interior trim & stops Interior wall surface SASH: Lowest rail please see above description Other rails & stiles Muntins & mullions	one of the window components are in functioning condition.	
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SASH: Lowest rail please see above description Other rails & stiles Muntins & mullions		
Lowest rail please see above description Other rails & stiles Muntins & mullions	e	
Other rails & stiles Muntins & mullions		
Muntins & mullions	please see above description	
Meeting rails (double- and single-hung)	s	
meeting rane (acable and single name)	ole- and single-hung)	
Glazing putty & gaskets	skets	
FUNCTION:		
Handles please see above description	please see above description	
Movement mechanics	nics	
Locks		
"Square"		
Weatherstripping		